#### General Notes:

- . Exterior walls are 2x6
- 2. Celling helght is 9' exc. where noted
  3. Windows are United 3900 single hung with low-e glass (30 maximum U factor)
  4. All smoke/carbon monoxide detectors to be interconnected with battery backup

- 4. All smoke/carbon monoxide detectors to be interconnected
  5. Roof to be stick built (trusses on garage)
  6. HYAC and kitchen design by others
  7. All Joist hangers to be fastened with manufacturer approved nalls and in accordance with manufacturer's instructions
  8. All lumber to be #2 Hem-Fir or better

- All lumber to be "\*L Hem-III or better
   All window and door headers to be 2 2xIO unless noted otherwise
   All bedrooms to have egress with 5.7 8F, 20" wide and 24" high clear opening
   All interior passageways to be drywall (add i" for R.O.)
   Crawlepace to be used for return air (I CFM per BO SF)

- 13. All plumbing vents to rear of roof14. All hangers and fasteners in contact with treated lumber to be hot dipped galv.
- 15. All bathrooms to have 50 CFM exhaust fan
- 16. HVAC to be electric heat pump field located by mechanics
- 17. House to be wrapped with Tyvek including gables 18. All window and door openings to have non-corrosive flashing applied shingle style

### 14 risers @ 7.7"


Treads to be 9.5" plus nosing
Builder to know and understand all stair codes
and adjust framing if necessary to comply

Insulation Schedule Crawispace Walls - RIO House Walls - R23 Flat Ceiling - R49 Sloped Ceiling - R30


6F Calculations First Floor - 1861 Unfinished Bonus Room - 288 Front Porch - 156 Garage - 570

OPENING SCHEDULE			
PRODUCT CODE	R.O. SIZE (WxH)		
Front gable combo	R,.0, 5'-0" x 4'-6"		
6H3O5O-2/CT6O	R.O. 6'-0" x 8'-0"		
6H2O3O	R.O. 2'-0" x 3'-0"		
SH2O3O-2	R.O. 4'-0" x 3'-0"		
6H243O	R.O. 2'-4" × 3'-0"		
6H3 <i>O</i> 5 <i>O</i> -2	R.O. 6'-0" x 5'-0"		
6H3O6O	R.O. 3'-0" x 6'-0"		
6H3 <i>0</i> 5 <i>0</i>	R.O. 3'-0" x 5'-0"		
СТБО	R.O. 5'-0" x 2'-6"		
5068 patio door	By manufacturer		
Front Door	By manufacturer		

Builder to verify all rough openings

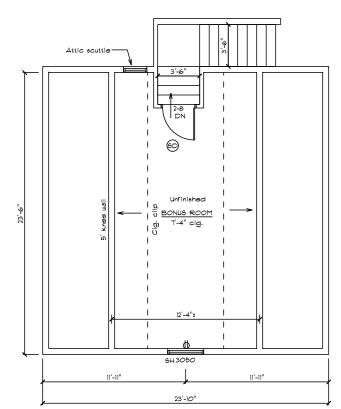

Bonus Room Floor Plan

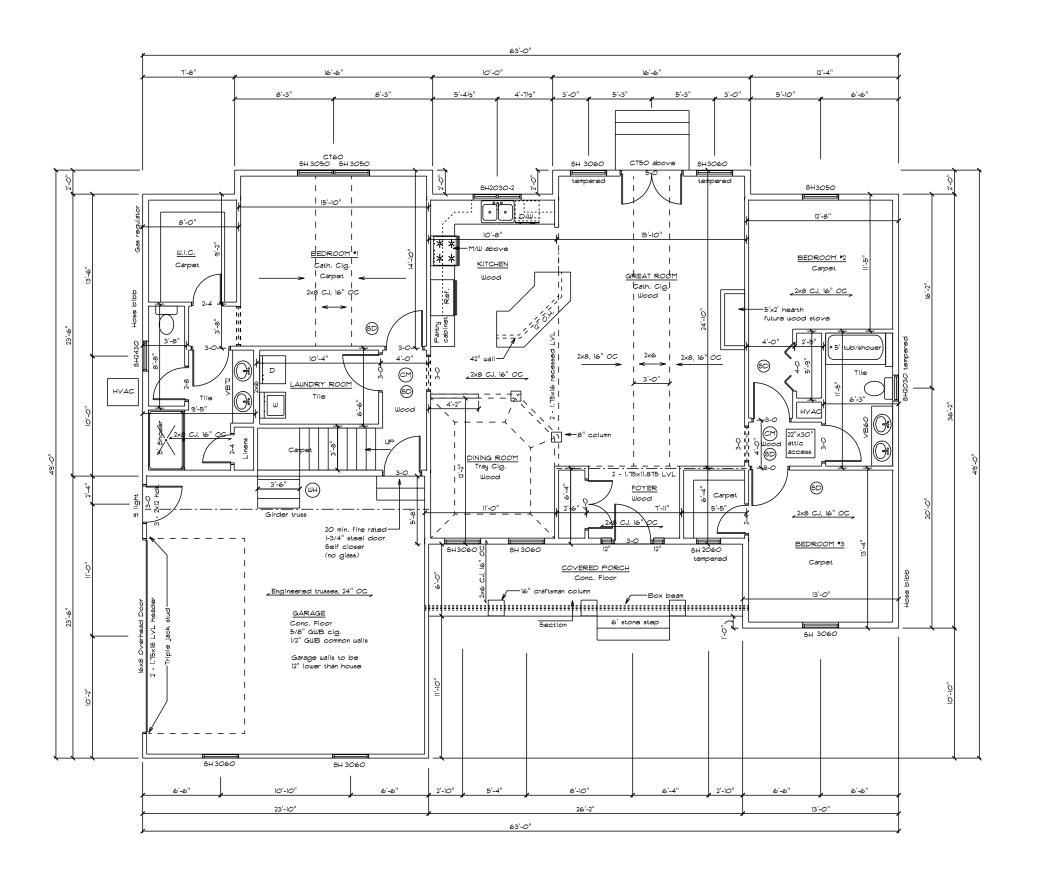

## Home Design Plus, Inc.

Owner/Contractor assumes responsibility of building to applicable codes
Designer is not responsible for mistakes found after construction is begun
Designer is not a licensed architect
No warranty is expressed or implied

Contractor	Rowland	9cale 1/4"=1'-0"	Approved	Revised
Accessible Home Builders	Floor Plans	1/6/2020	Drawn By John Warfel	Drawing Number


- Foundation Notes:

  1. Builder to ensure proper soil bearing capacity

  2. Crawlepace walls to be insulated with RIO rigid foam

  3. Crawlepace floor to be 6 mil poly taped at seams and walls

  4. Crawlepace to be used for HVAC return (1 CFM per 50 6F)

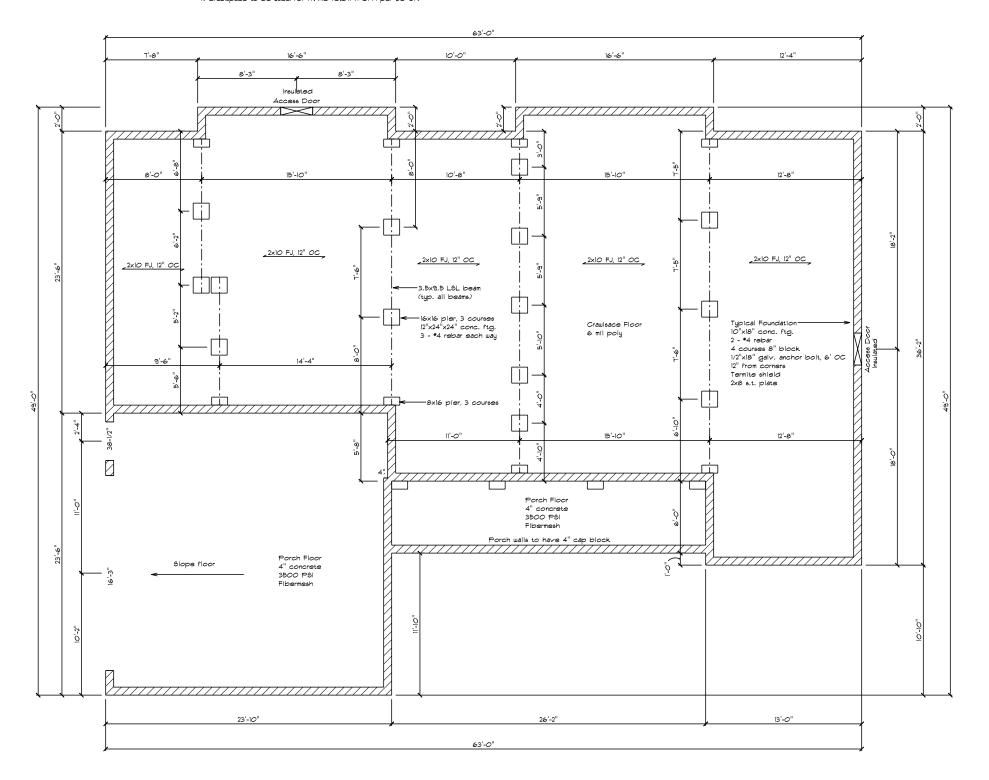

# Home Design Plus, Inc.

Contractor	Rowland	Scale 1/4"=1'-0"	Approved	Revised
Accessible Home Builders	Foundation Plan	1/6/2020	Drawn By John Warfel	Drawing Number 2







Home Design Plus, Inc.


8048 Hidden Meadow Lane Greenwood, DE 19950 302-424-3998 Disclaimers

Owner/Contractor assumes responsibility of building to applicable codes
Designer is not responsible for mistakes found after construction is begun
Designer is not a licensed architect
No warranty is expressed or implied


Contractor	Rowland	Scale 1/4"=1'-0"	Approved	Revised
Accessible Home Builders	Elevations	1/6/2020	Drawn By John Warfel	Drawing Number

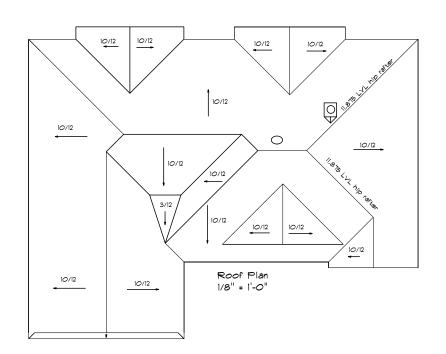

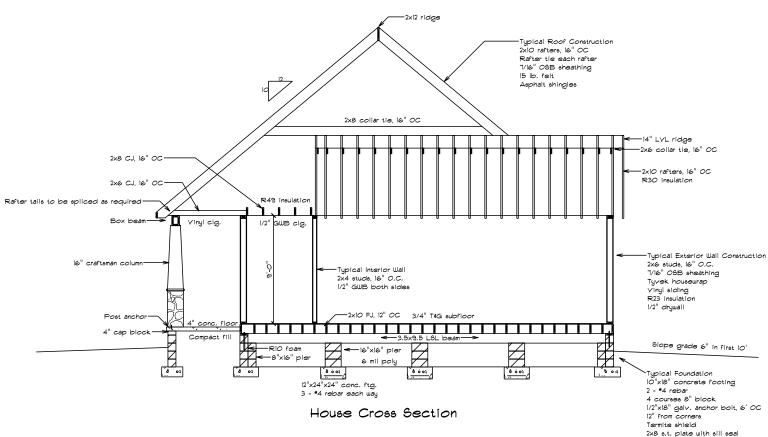


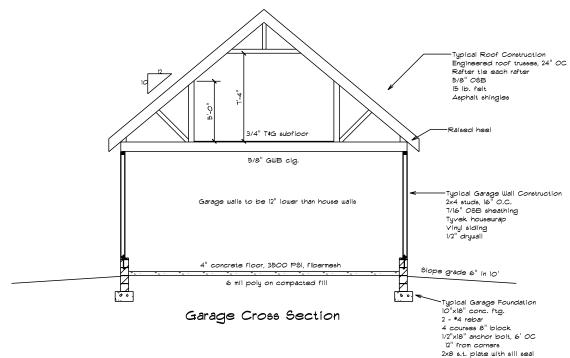

Contractor	Rowland	Scale 1/4"=1'-0"	Approved	Revised
Accessible Home Builders	Cross Section/Roof Plan	1/6/2020	Drawn By John Warfel	Drawing Number 4

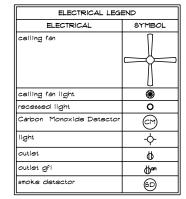

All electrical work to be per NEC

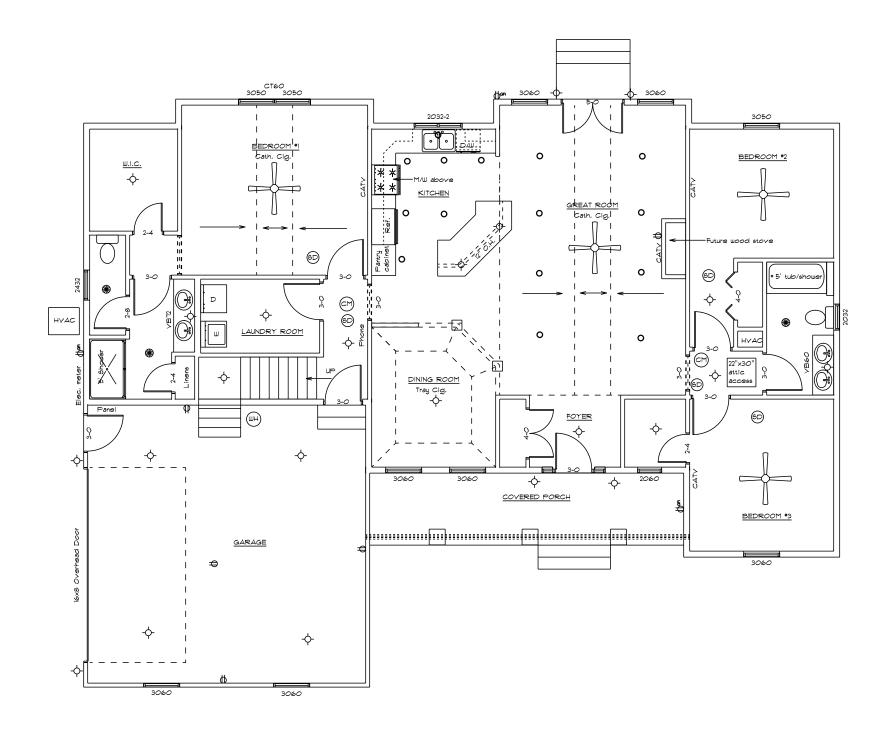

# Home Design Plus, Inc.

Contractor	Rowland	Scale 1/4"=1'-0"	Approved	Revised
Accessible Home Builders	Electrical Plan	1/6/2020	Drawn By John Warfel	Drawing Number 5